

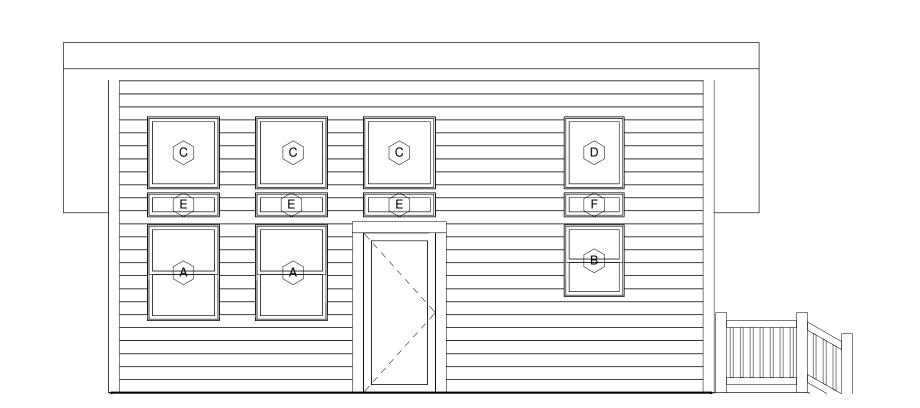
		WINDOW SCHEDULE		
Quantity	ID	Style and Type	Width	Height
			•	
5	Α	Double Hung: 36" x 48"	3' - 0"	4' - 0"
1	В	Double Hung: 30" x 36"	2' - 6"	3' - 0"
3	С	Fixed: 36" x 36"	3' - 0"	3' - 0"
1	D	Fixed: 30" x 36"	2' - 6"	3' - 0"
3	Е	Fixed: 36" x 12"	3' - 0"	1' - 0"
1	F	Fixed: 30" x 12"	2' - 6"	1' - 0"

DOOR SCHEDULE					
Quantity	ntity ID Function Style and Type		Width	Height	
1	1	Exterior	Single-Glass 1: 36" x 80"	3' - 0"	6' - 8"
1	2	Interior	Single-Panel 4: 32" x 80"	2' - 8"	6' - 8"
1	3	Interior	Single-Panel 4: 30" x 80"	2' - 6"	6' - 8"
1	4	Interior	Single-Panel 4: 36" x 80"	3' - 0"	6' - 8"
1	5	Interior	Single-Panel 4: 32" x 80"	2' - 8"	6' - 8"

NOTE:
ALL DOORS/WINDOWS ARE TO BE VERIFIED IN THE

FIELD TO DETERMINE ACTUAL SIZE AND PLACEMENT.

ALL DORRS/WINDOWS SIZES AND TYPES TO BE DETERMINED PER OWNER/BUILDER.



3 UPPER WINDOW SCHEDULE 1/4" = 1'-0"

DANIEL LEMMON DESIGNS

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TOSTON MT, 59643

REVISIONS			
Drawn By:	Date:		
D. LEMMON	3/15/20		

PROJECT DESCRIPTION

WALL TYPE	2x6 Framed Wall
SIDING	2x8 Log Siding
STYLE	Single Level
ROOF TYPE	Metal
FINISH	Cedar Tone Stain

These drawings may not be reproduced, photocopied, transmitted electonically, or altered without the written permission of the original author.

It is the sole responsibility of the

contractor/owner to check and verify all dimensions and specifications on this set of plans before starting construction.

Report any discrepencies, errors or omissions to the designer.

Builder is responsible for complying with all local building codes and

CONSTRUCTION DRAWINGS

Drawn By: DANIEL LEMMON

Address:

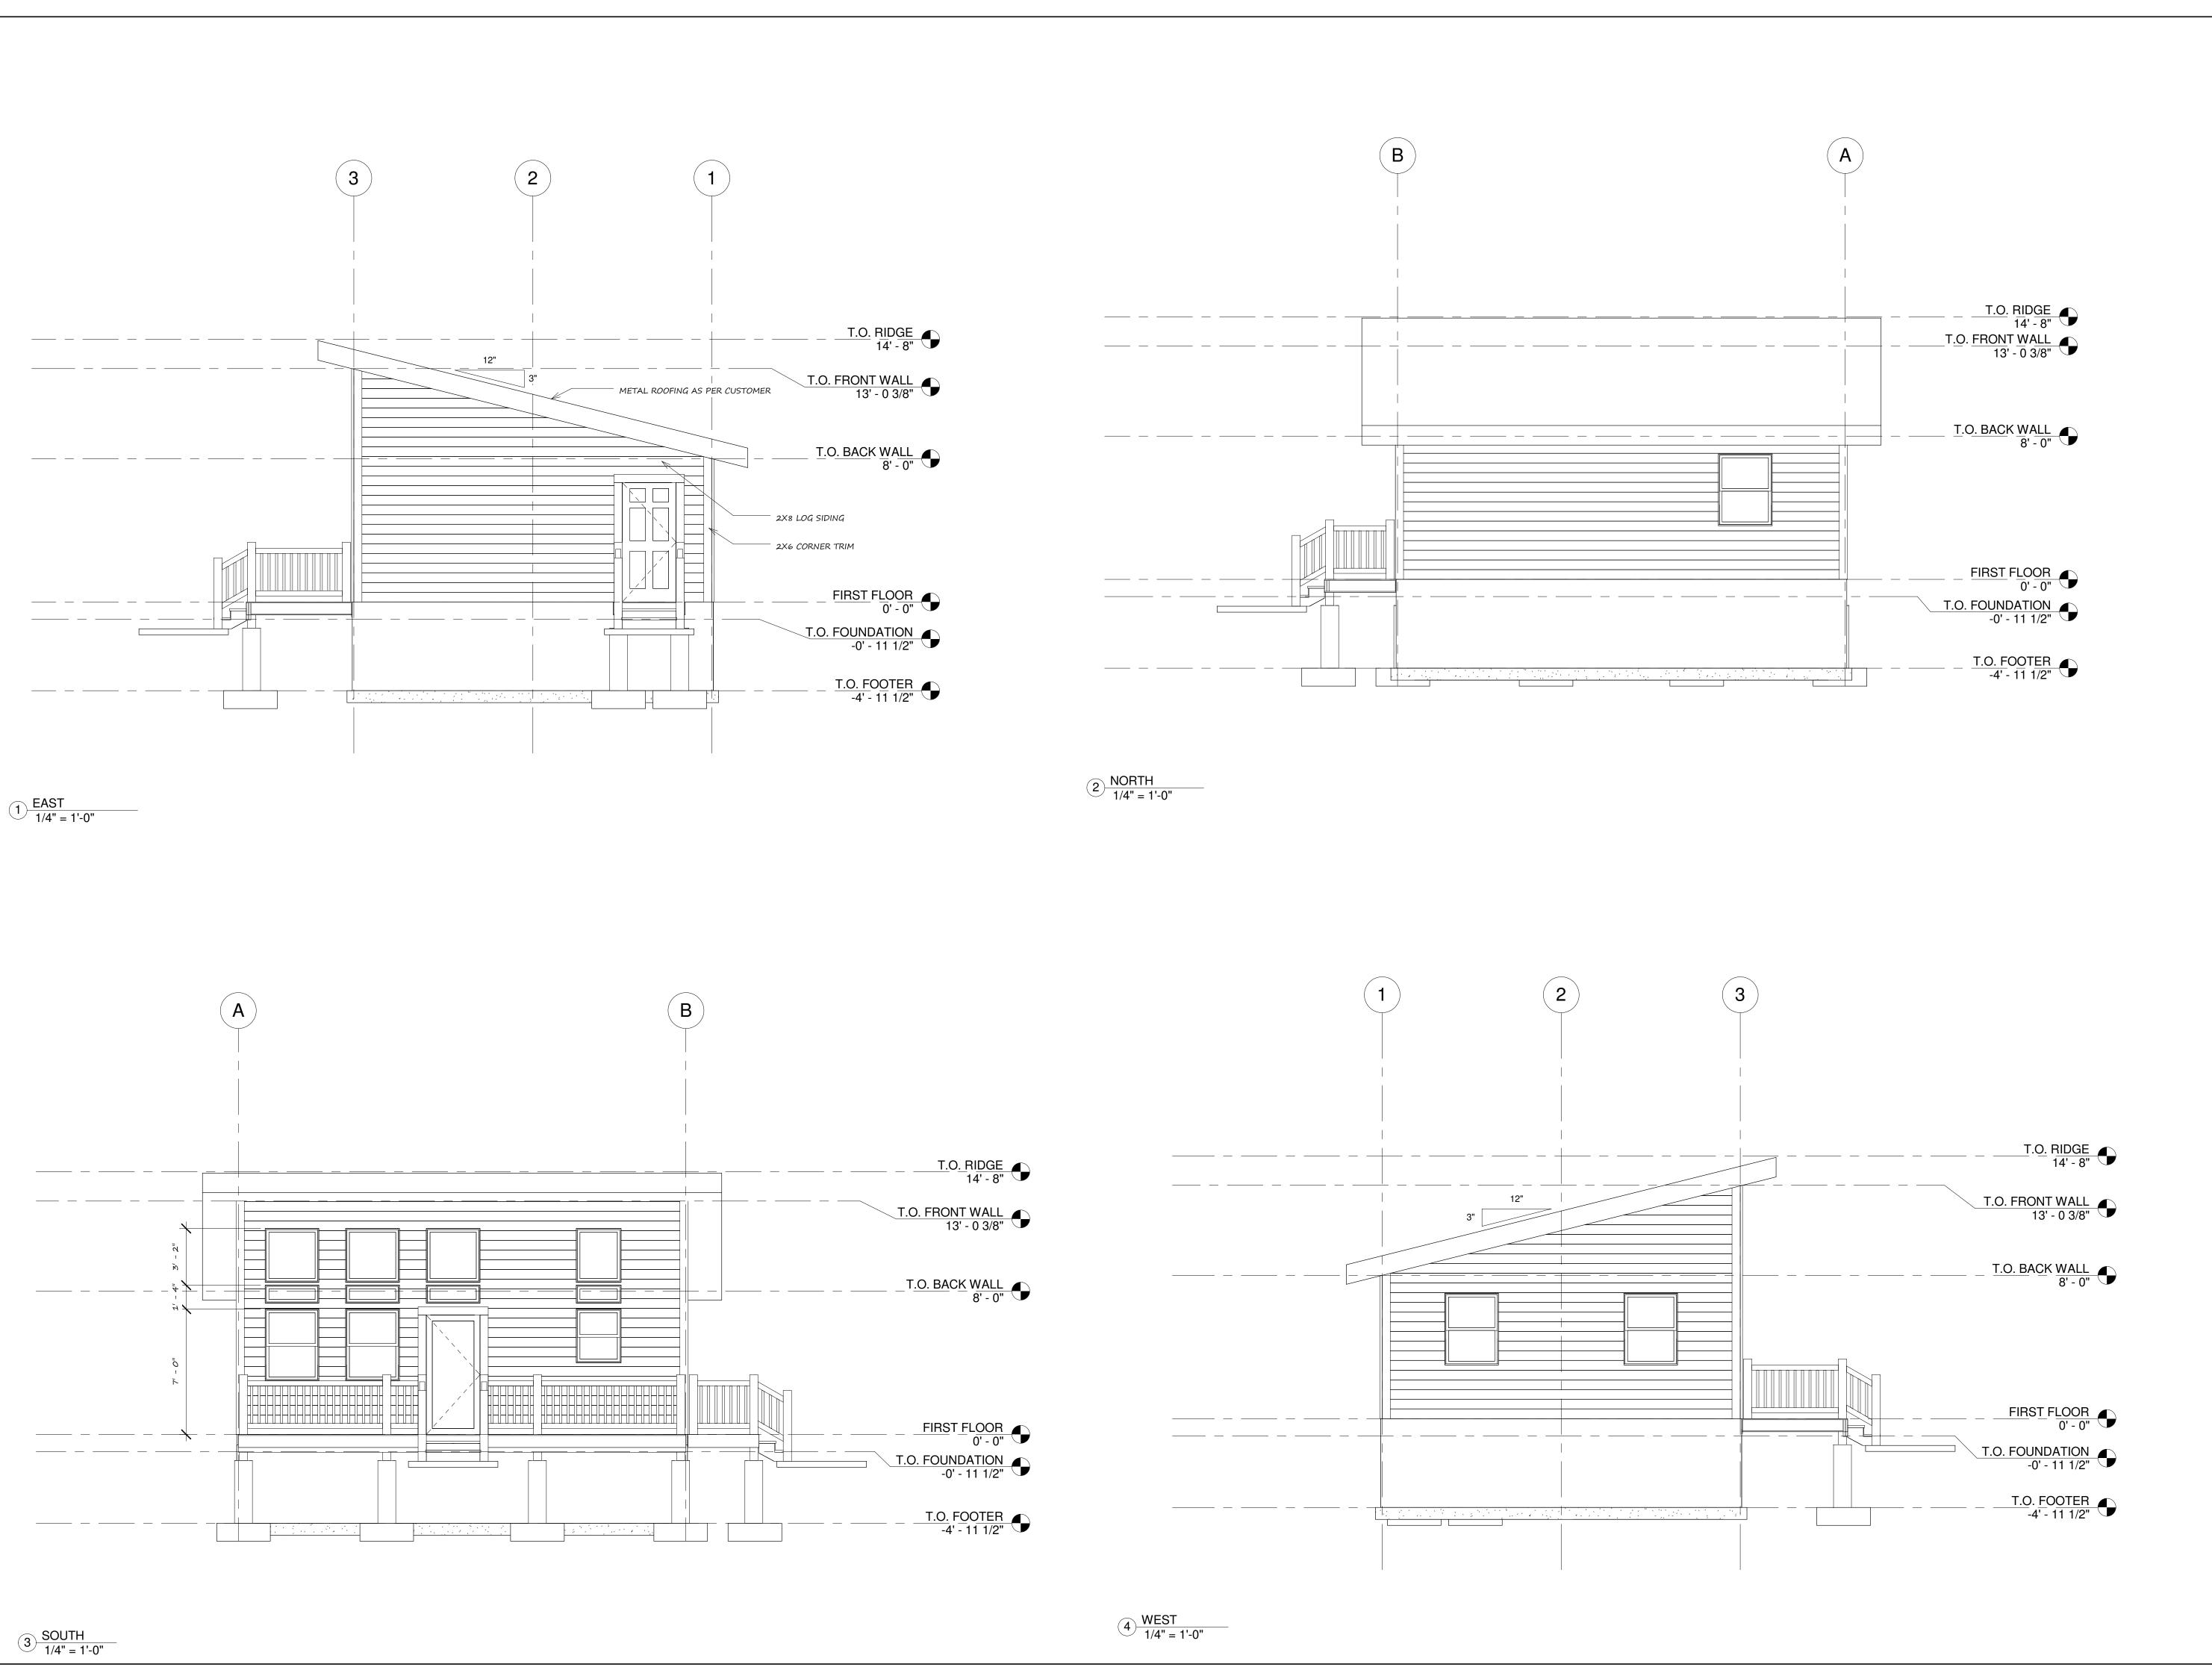
Address: 99 Buffalo Jump Trail Address: Toston, MT 59643

County: Broadwater
Phone: (406) 388-3458
DanielLemmonDesigns@yahoo.com

WEEKEND CABIN

FLOOR PLAN

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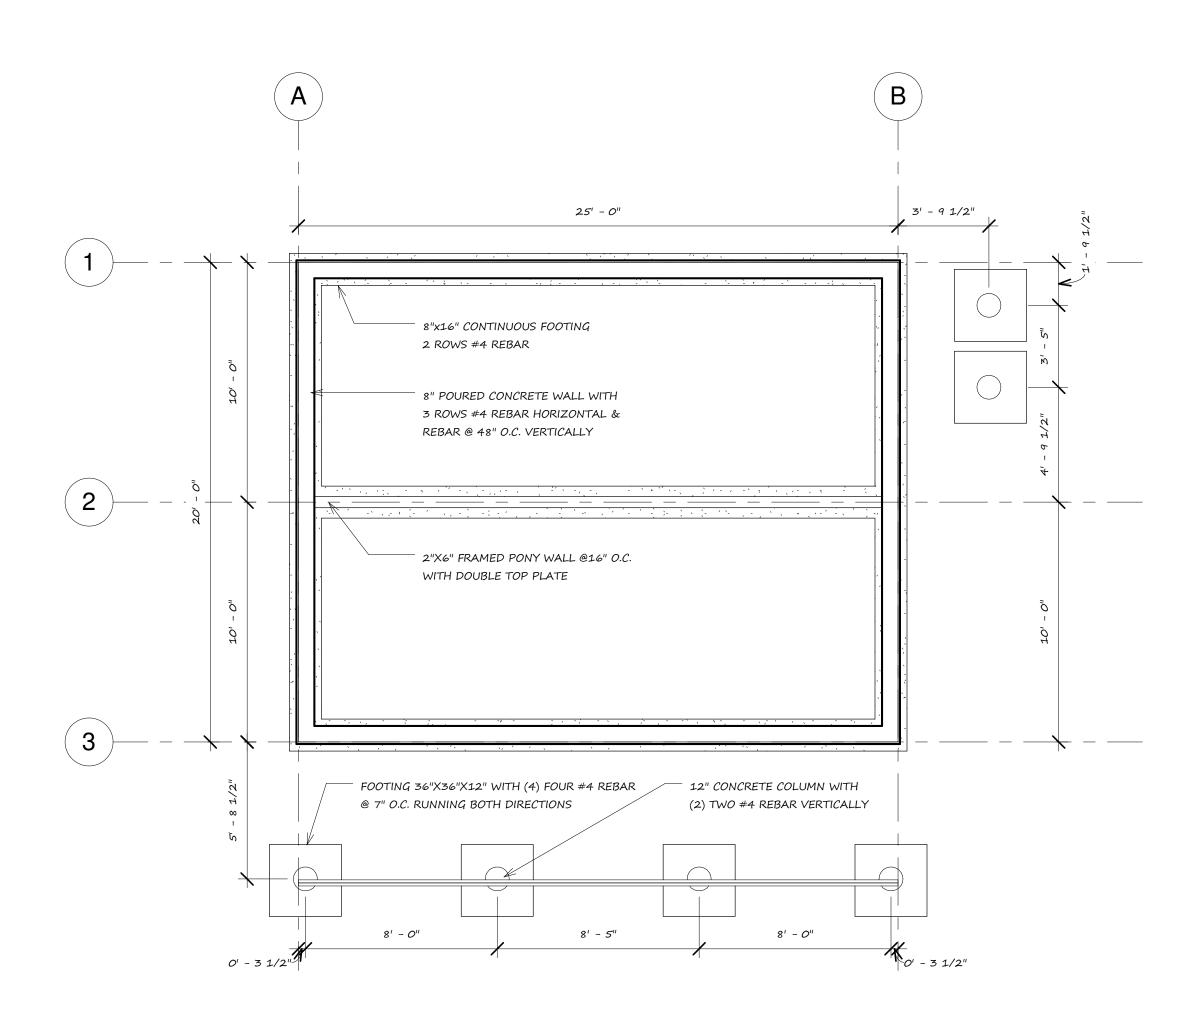
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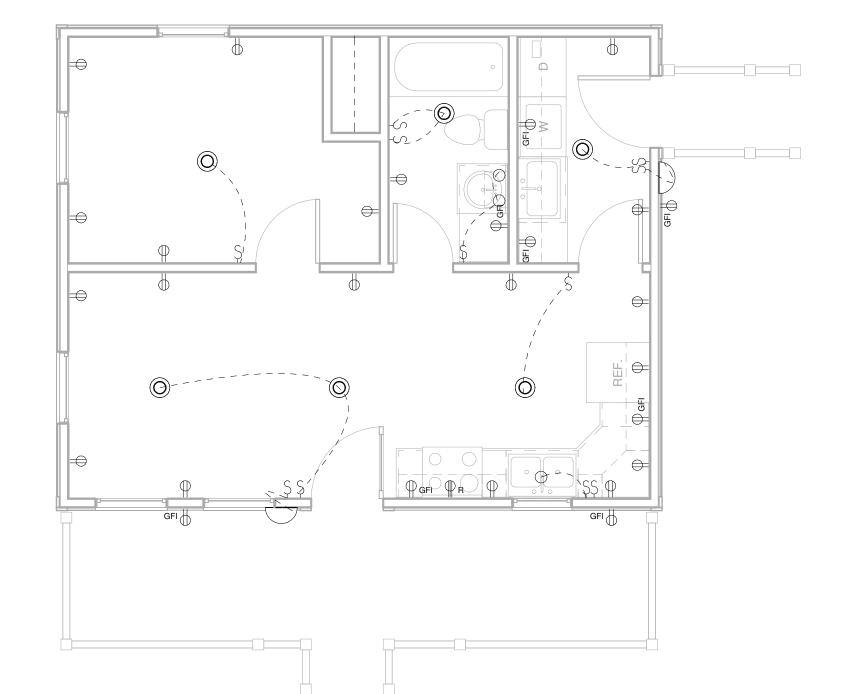
WEEKEND CABIN

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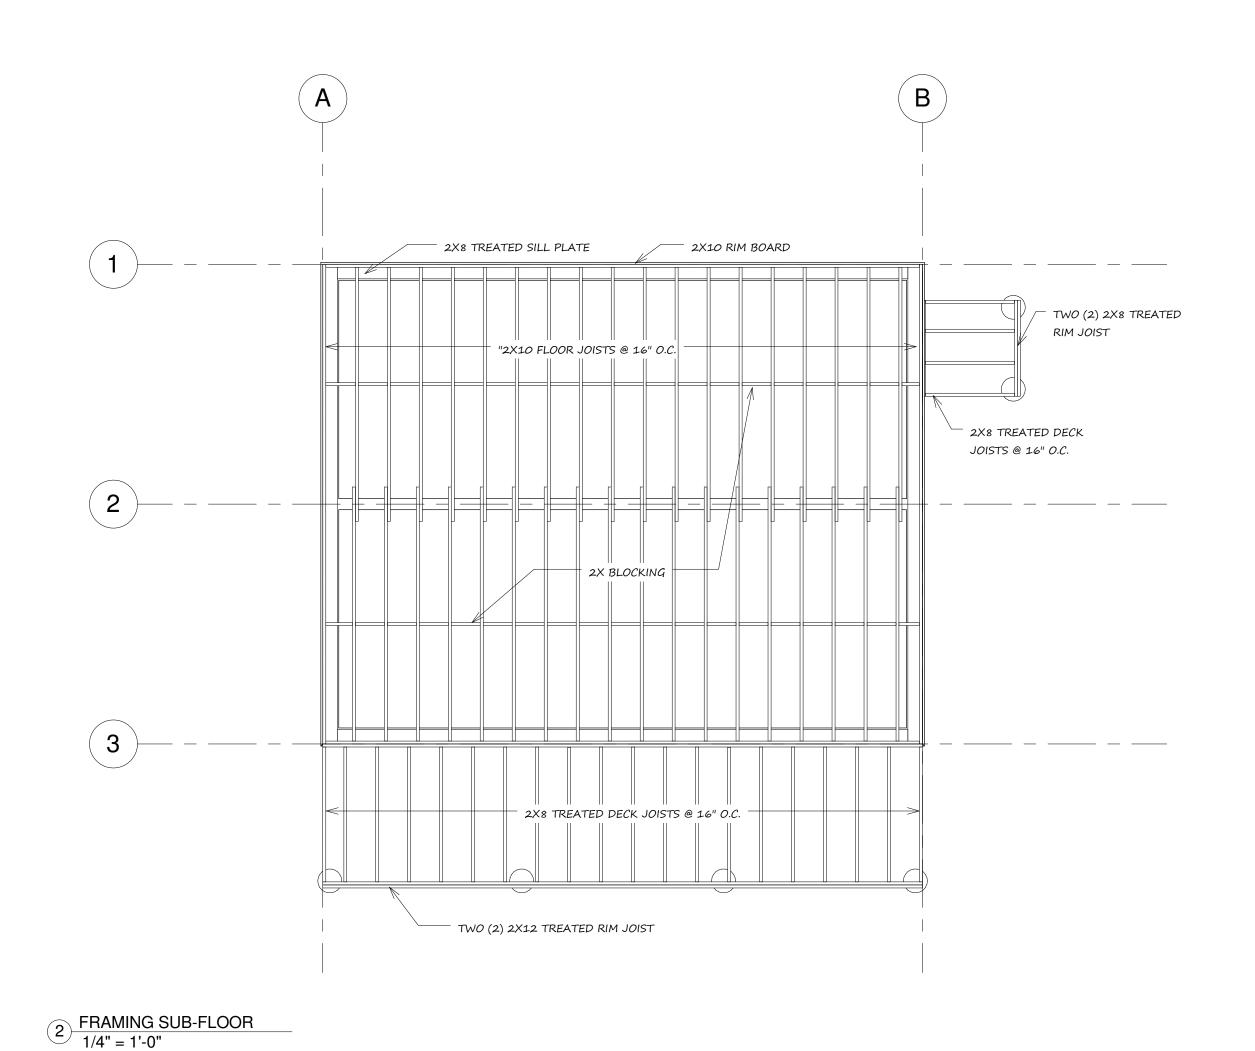
ELEVATIONS



1) FOUNDATION 1/4" = 1'-0"



4 ELECTRICAL 1/4" = 1'-0"



3 ROOF FRAMING

(3) ROOF FRAMING

(4) ROOF FRAMING

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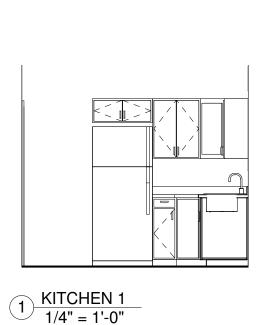
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WEEKEND

CABIN

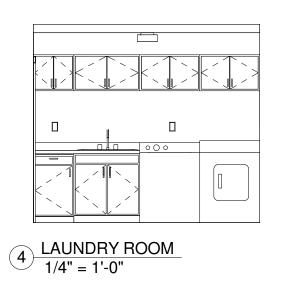
STRUCTURAL

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GENERAL NOTES:

- 1 These plans were drawn by a Designer not an Engineer or an Architect. The Designer recommends that these plans be reviewed and stamped by a Structural Engineer.
- The Contractor/Owner is to review & verify these plans in their entirety before attempting to build. Any & all discrepencies are to be reported to the Designer. Any errors due to not reviewing these plans are the responsibility of the Contractor/Owner.
- If a Structural Engineer is not contracted at the owners request to size all structural portions of this building then the owner & or builder will be responsible for all structural designs. By building this structure without proper engineering the owner & or builder are in agreement to accept all responsibility & liability for this building
- 4 All building methods by the Owner, Builder, Contractors, Subcontractors, or any person or entities employer or contracted to work on the building are to comply with the local building codes in there entirety and with no exceptions. If there are no local building codes then all participating parties are to comply with the States building codes or the current UBC or IBCO building codes.
- All specifications in the designs indicate the building in the finished state. The parties building all or part of the building are responsible for sound, current, and safe building practices, and on-site safety. This includes proper support for partial walls, roofs, decks, etc. The parties building all or part of the building shall not overload any portion of the home and shall have no loads that exceed the maximum indicated by the engineer (if applicable to this building) for any duration of time, temporary or permanent.
- 6 The Owner/Contractor shall verify all materials and existing conditions at the job site, and fully coordinate all dimensions and conditions of details with other disciplines before attempting to build.
- Any and all variances due to the Owner/Contractor or any other party without written consent in the design stage or afterwards will void all liabilities from the Engineers, Designer, and any other parties involved in the design stages of the building. The Owner and/or Contractor agree to hold harmless all parties involved in the design stage from any claims resulting from variances.
- 8 In an event of a conflict between pertinent codes and regulations and referenced standards on the plans, the more stringent provisions will govern.
- Any design loads shown are assumed loads. The Owner/Contractor are responsible for checking the actual soil and snow load requirements. The Owner/Contractor are responsible for obtaining a soils report if necessary.

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